

GENERAL NOTES:

THE STORM CAPTURE™ SYSTEM BY OLDCASTLE PRECAST IS PART OF THE STORMWATER MANAGEMENT SYSTEM FOR THE RESPECTIVE SITE, AS PREPARED BY THE PROJECT DESIGN ENGINEER. IT IS THE RESPONSIBILITY OF THE DESIGN ENGINEER TO DETERMINE DESIGN FLOW RATES, PRE-TREATMENT AND POST-TREATMENT REQUIREMENTS, STORAGE VOLUME, AND ENSURE THE FINAL DESIGN MEETS ALL CONVEYANCE AND STORAGE REQUIREMENTS. SYSTEM DESIGN AND TYPE, SOIL ANALYSIS, LOADING REQUIREMENTS, COVER HEIGHT AND MODULE SIZE DETERMINE THE FOUNDATION TYPE AND REQUIREMENTS AS STATED HEREIN. ANY VARIATIONS FOUND DURING CONSTRUCTION FROM THE SITE AND SYSTEM ANALYSIS MUST BE REPORTED TO THE PROJECT DESIGN ENGINEER. THE PROJECT DESIGN ENGINEER IS RESPONSIBLE FOR OBTAINING A GEOTECHNICAL ENGINEERING REPORT VERIFYING THE BEARING CAPACITY STATED IN DESIGN NOTES.

DESIGN NOTES:

1. DESIGN LOADINGS:

A. AASHTO HS-20-44 W/ IMPACT.

B. DEPTH OF COVER = 6" - 5'-0".

C. ASSUMED WATER TABLE = BELOW BOTTOM.

D. EQUIVALENT FLUID PRESSURE = 45 PCF.

E. LATERAL LIVE LOAD SURCHARGE = 80 PSF.

F. NO LATERAL SURCHARGE FROM ADJACENT STRUCTURES.

2. CONCRETE 28 DAY COMPRESSIVE STRENGTH SHALL BE 6,000 PSI.

3. STEEL REINFORCEMENT: REBAR, ASTM A-615, GRADE 60.

4. CEMENT: ASTM C-150 SPECIFICATION.

5. STORM CAPTURE MODULE TYPE = DETENTION.

6. REQUIRED BASE LAYER DEPTH = 2" SAND BEDDING LAYER.

7. REQUIRED NATIVE ALLOWABLE SOIL BEARING PRESSURE = 3,000 PSF.

8. REFERENCE STANDARDS:

A. ASTM C 890

B. ASTM C 891

C. ASTM C 913

9. LESS THAN 6" OR GREATER THAN 5' OF COVER REQUIRES CUSTOM STRUCTURAL DESIGN AND MAY REQUIRE THICKER SUBGRADE.
- INSTALLATION NOTES:
- THE STORM CAPTURE™ MODULE SYSTEM IS TO BE INSTALLED IN ACCORDANCE WITH ASTM C891, INSTALLATION OF UNDERGROUND PRECAST UTILITY STRUCTURES. PROJECT PLAN AND SPECIFICATIONS MUST BE FOLLOWED ALONG WITH ANY APPLICABLE REGULATIONS.

1. PLAN LINE, GRADE AND ELEVATIONS MUST BE FOLLOWED.

2. WHERE SPECIFIED, AN 8 OZ. NON-WOVEN GEOTEXTILE FABRIC MUST BE USED AS A SEPARATION LAYER AROUND THE STORM CAPTURE SYSTEM.

3. PENETRATIONS IN THE GEOTEXTILE MAY ONLY BE MADE WITH SMOOTH WALL PIPES. MAKE PENETRATIONS FOR ALL OUTLETS BEFORE MAKING PENETRATIONS FOR ANY INLETS.


4. ALL SUBGRADE MATERIALS IF SPECIFIED, MUST BE CLEAN, DURABLE CRUSHED AGGREGATE COMPACTED OR ROLLED TO ACHIEVE 95% STANDARD PROCTOR DENSITY. OLDCASTLE RECOMMENDS SIZE 5.56,OR 57 (PER ASTM C33) .

5. DESIGNATED EMBEDDED LIFTERS MUST BE USED. USE PROPER RIGGING TO ASSURE ALL LIFTERS ARE EQUALLY ENGAGED WITH A MINIMUM 60 DEGREE ANGLE ON SLINGS AS NOTED AND IN ACCORDANCE WITH OLDCASTLE LIFTING PROCEDURES.

6. MODULES MUST BE PLACED AS CLOSE TOGETHER AS POSSIBLE, AND GAPS SHALL NOT BE GREATER THAN 3/4". ALL EXTERIOR SYSTEM JOINTS SHALL BE COVERED WITH A MIN. 8" JOINT WRAP ON SIDES AND TOP (CS-212 CONSEAL OR EQUIVALENT). IN A CLAMSHELL DESIGN INSTALL ONE ROW CS-102 CONSEAL (OR EQUIVALENT) BETWEEN PRECAST PIECES.


7. AUTHORIZATION SHOULD BE GIVEN BY THE PROJECT ENGINEER OR DESIGNATED PERSON PRIOR TO PLACEMENT ON BACKFILL FOR THE SYSTEM. CARE SHOULD BE TAKEN DURING PLACEMENT OF BACKFILL NOT TO DISPLACE MODULES OR JOINT WRAP. BACKFILL SHALL BE COMPACTED TO 95% STANDARD PROCTOR DENSITY OR AS SPECIFIED, AND SHOULD NOT BE COMPACTED WITHIN 6" OF MODULE.

8. CONSTRUCTION EQUIPMENT EXCEEDING DESIGN LOADING SHALL NOT BE ALLOWED ON STRUCTURE.

9. TERMADUCTS TO BE KNOCKED OUT AT SPECIFIED LOCATIONS IN FIELD BY OTHERS. SEE SITE LAYOUT FOR LOCATIONS.
- INLETS AND RISERS:
- ALL PIPE INLETS SHALL EXTEND INSIDE MODULE A MINIMUM OF 4". PLACE A NON-SHRINK, NON-METALIC GROUT, MIN. 3,000 PSI IN ANNULAR SPACE TO ELIMINATE ALL VOIDS.
- STORMCAPTURE®
- TABLE OF CONTENTS
- |                     |   |
|---------------------|---|
| NOTES & GENERAL ISO | 1 |
| TYPICAL ELEVATION   | 2 |
| EXTERIOR DETAILS    | 3 |
| INTERIOR DETAILS    | 4 |
- NOTE: THIS VIEW IS FOR ILLUSTRATION PURPOSES ONLY TO SHOW FEATURES OF THE SYSTEM. ACTUAL LAYOUT VARIES BY PROJECT, SEE SITE PLAN LAYOUT. ALL PERIMETER WALLS ARE SOLID.
- 
- BOTTOM MODULE WITH TOP SLAB ISO VIEW**  
N.T.S.
- \*THIS MUST BE FILLED OUT BEFORE MANUFACTURING BEGINS\*
- APPROVED W/ NO EXCEPTIONS TAKEN: ☐  
APPROVED AS NOTED: ☐  
REVISE AND RESUBMIT: ☐
- PRELIMINARY -  
NOT FOR CONSTRUCTION
- SIGNATURE \_\_\_\_\_ DATE \_\_\_\_\_
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**Oldcastle®**  
Stormwater Solutions


7821 SOUTHPARK PLAZA, SUITE 200, LITTLETON, CO 80120  
PHONE: 1-888-965-3227 FAX: 303-794-7487
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- STORMCAPTURE**  
NOTES & GENERAL ISO
- CUSTOMER \_\_\_\_\_
- |                              |           |           |             |          |             |
|------------------------------|-----------|-----------|-------------|----------|-------------|
| DATE                         | SALES STS | DRAWN STS | ENGINEER JH | CHECKED  | SALES ORDER |
| DRAWING NUMBER               |           |           |             | REVISION | SHEET       |
| SC - 5 ft base with top slab |           |           |             | REV DATE | 1 OF 4      |

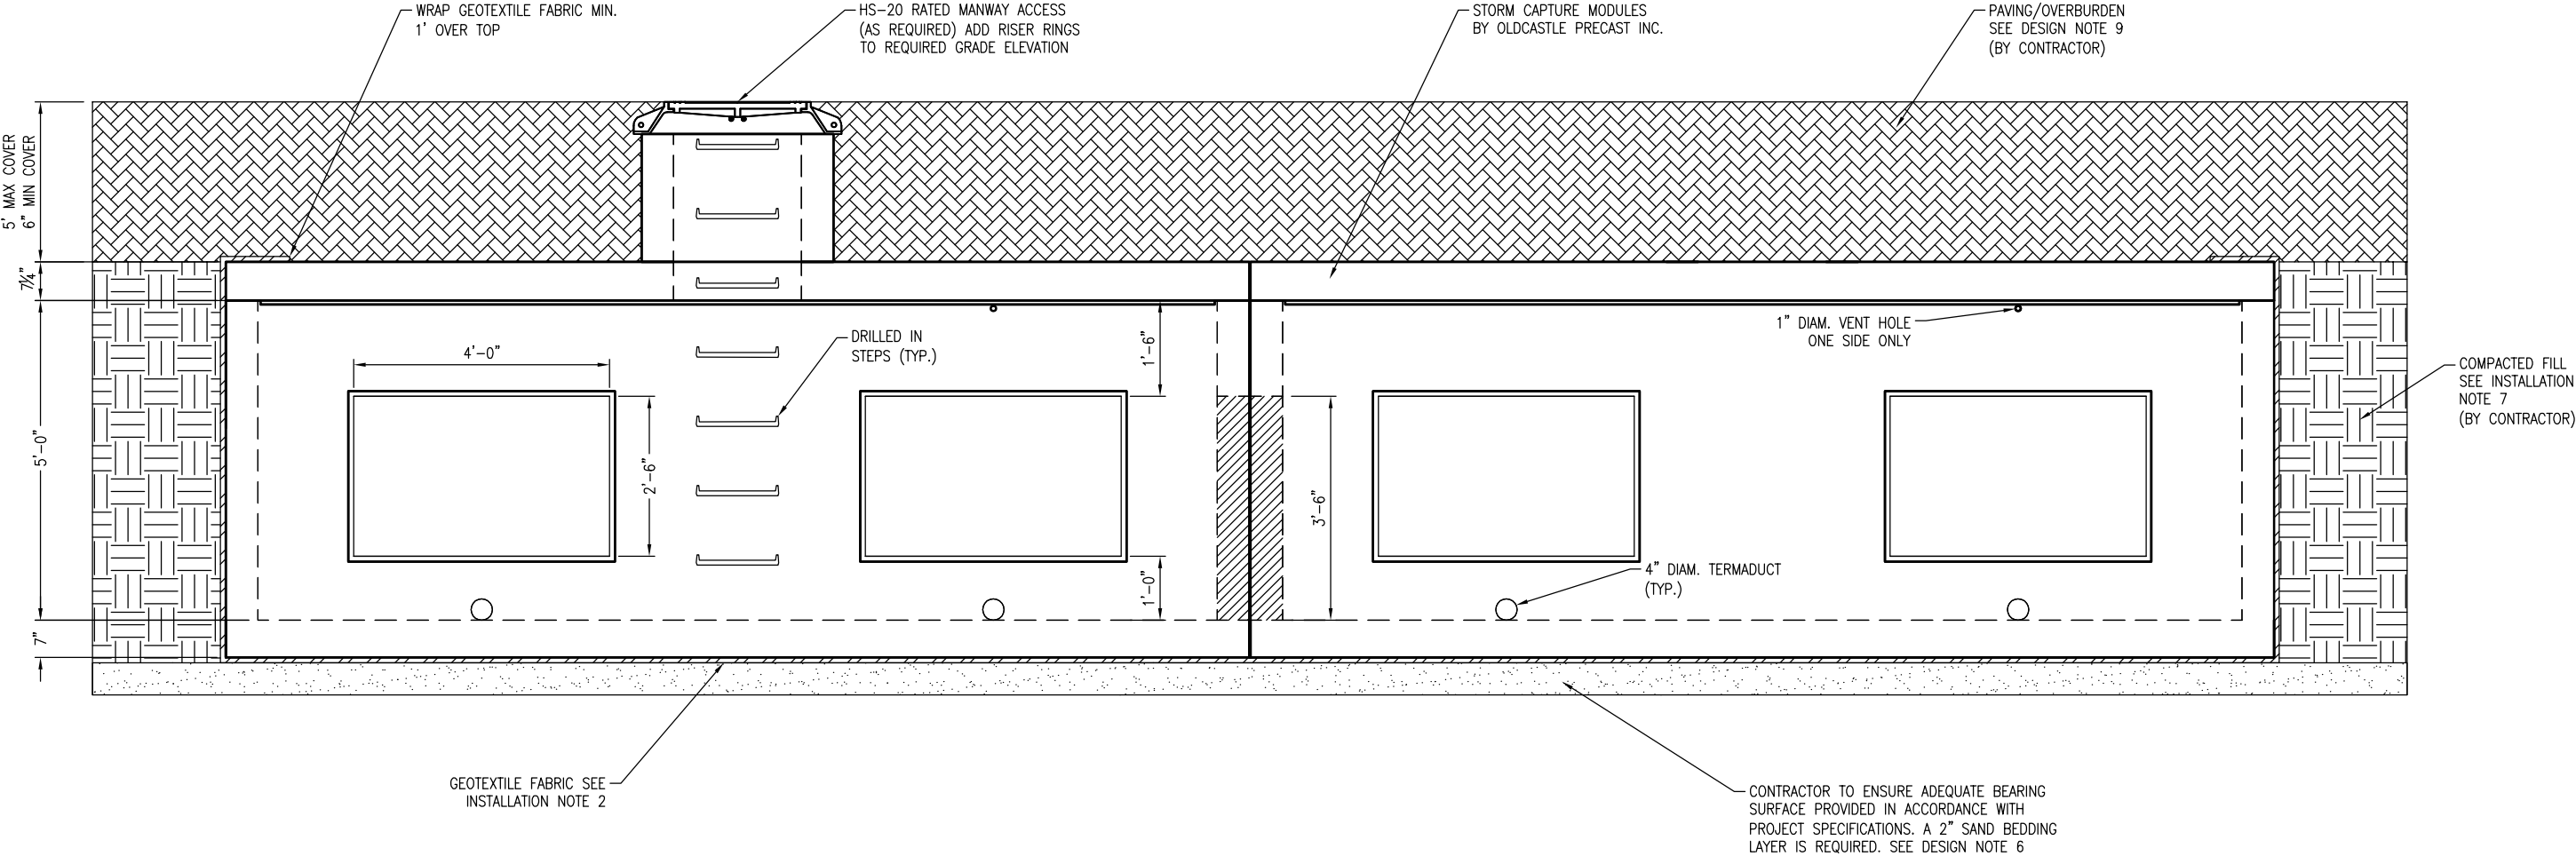

TYPICAL ELEVATION  
SCALE: 3/8" = 1'-0"

NOTE:  
TERMADUCT INSERTS TO BE KNOCKED OUT AT SPECIFIED LOCATIONS ONLY (BY OTHERS).

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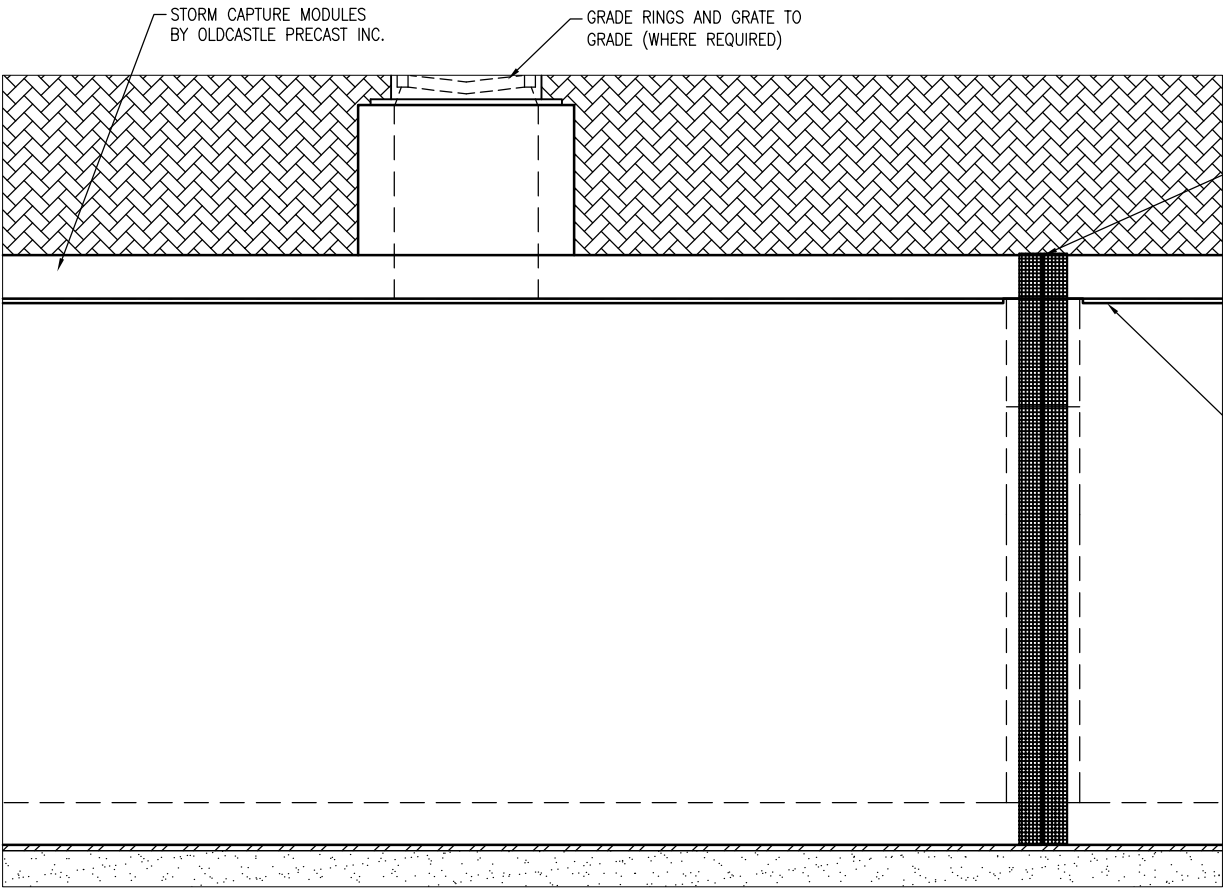
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**STORMCAPTURE**  
TYPICAL ELEVATION

CUSTOMER

DATE	SALES STS	DRAWN STS	ENGINEER JH	CHECKED	SALES ORDER
DRAWING NUMBER				REVISION	SHEET
SC - 5 ft base with top slab				REV DATE	2 OF 4




GRADED INLET DETAIL  
SCALE: 3/8" = 1'-0"

APPLY JOINT WRAP AROUND VERTICAL AND TOP JOINTS. SEE MODULE JOINT DETAIL.

APPLY CONSEAL CS-102 BUTYL RUBBER SEALANT BETWEEN TOP SLAB AND BOTTOM MODULE. SEE PLACEMENT DETAIL AT RIGHT.

NOTE: WEIR PLATES, IF REQUIRED, MAY BE INSTALLED WITH RED-HEAD ANCHORS (BY OTHERS). ELEVATIONS TO BE DETERMINED BY PROJECT DESIGN ENGINEER

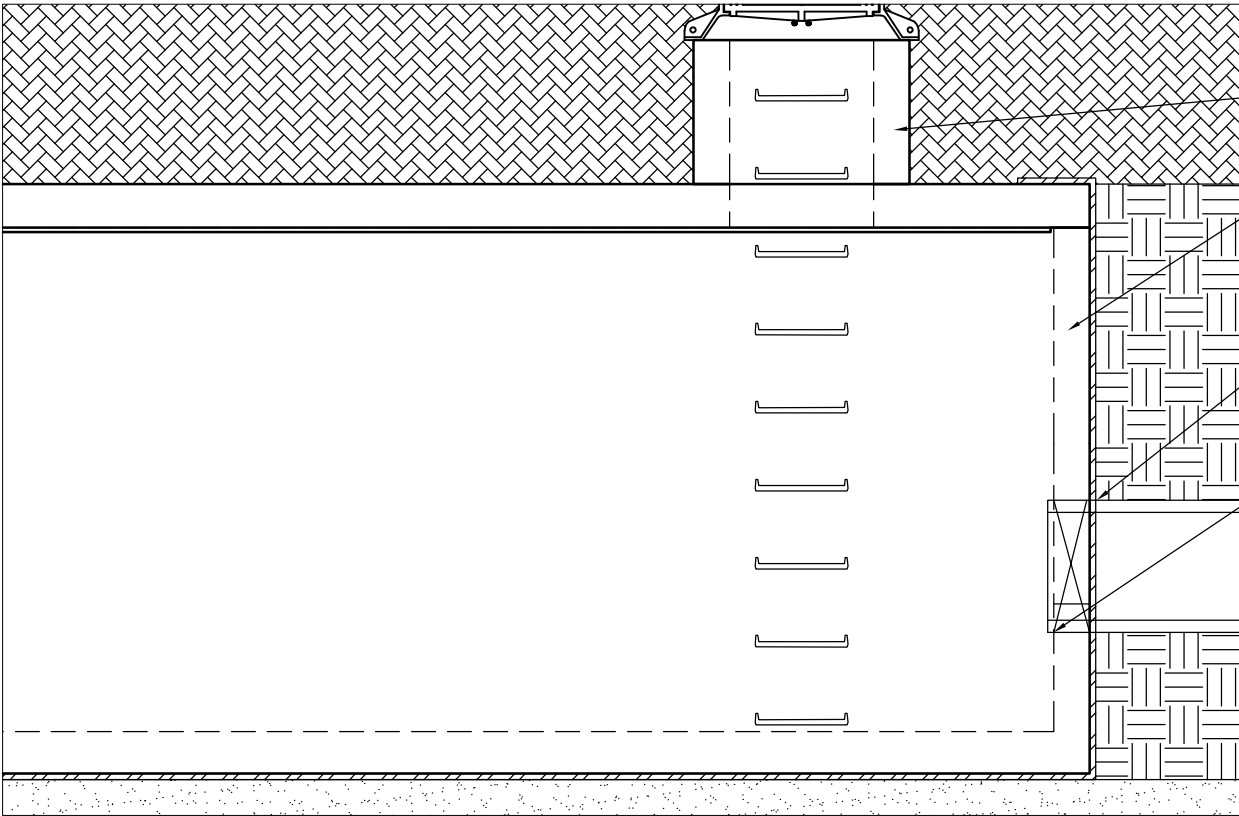

MANWAY ACCESS DETAIL  
SCALE: 3/8" = 1'-0"


MIN. 30" MANWAY ACCESS PROVIDED FOR EACH MAINTENANCE MODULE.

STORM CAPTURE MODULES BY OLDCASTLE PRECAST INC.


PIPE PENETRATION TO BE SEALED TO LINER WITH BOOT FOLLOWING LINER MANUFACTURERS RECOMMENDATIONS (INSTALLATION BY OTHERS)

PIPE ENTRANCE AS REQUIRED


KEYWAYS MUST BE FREE OF DIRT, ROCKS, AND WATER. ROCKS AND DIRT PREVENT THE VAULT SECTIONS FROM SEATING AND SEALING PROPERLY. REMOVE ALL PROTECTIVE PAPER FROM RUBBER SEALANT MATERIAL. SPLICE RUBBER SEALANT MATERIAL WITH A "SIDE BY SIDE" JOINT, AWAY FROM CORNERS. CORNER SPLICING WILL NOT SEAL PROPERLY.

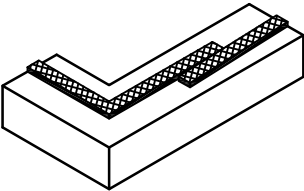

CORRECT – INSTALL RUBBER SEALANT MATERIAL AT THE OUTER EDGE OF THE KEYWAY. RUBBER SEALANT SHOULD BE CONTINUOUS AROUND CORNERS.

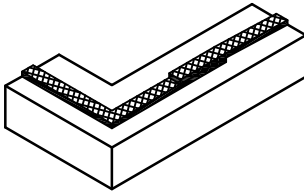


INCORRECT – DO NOT OVERLAP THE RUBBER SEALANT MATERIAL AT SPLICE.

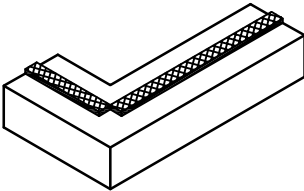

INCORRECT – DO NOT SPLICE RUBBER SEALANT MATERIAL AT A CORNER. RUBBER SEALANT SHOULD BE CONTINUOUS AROUND CORNERS.

CONSEAL CS-102 BUTYL RUBBER SEALANT  
PLACEMENT DETAIL  
NTS

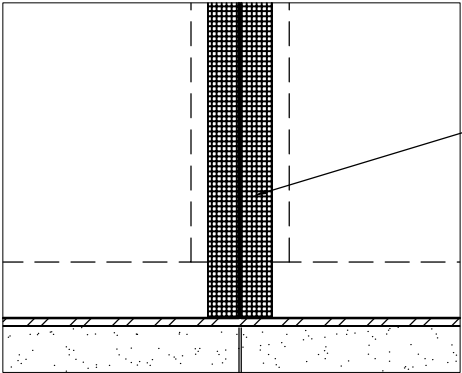

8" MIN. WIDE STRIP OF SELF-ADHESIVE OVER ENTIRE JOINT. PROVIDE MIN. 1' OVERLAP WHEN CONNECTING STRIPS. JOINT WRAP SUPPLIED BY OLDCASTLE AND INSTALLED BY OTHERS. SEE INSTALLATION NOTE 6.

1/4" GAP TYP. (3/4" MAX) BETWEEN STRUCTURES

MODULE JOINT DETAIL  
SCALE: 1/2" = 1'-0"

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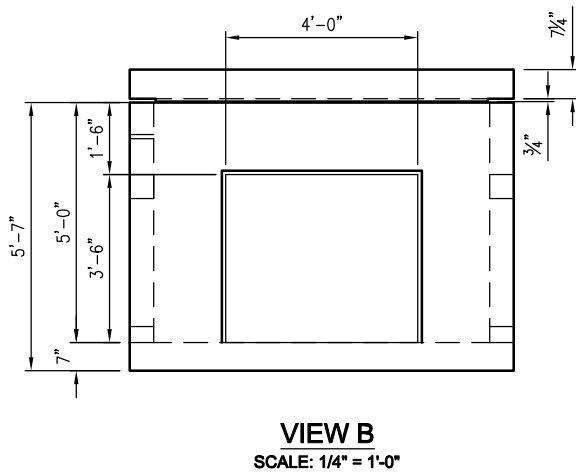
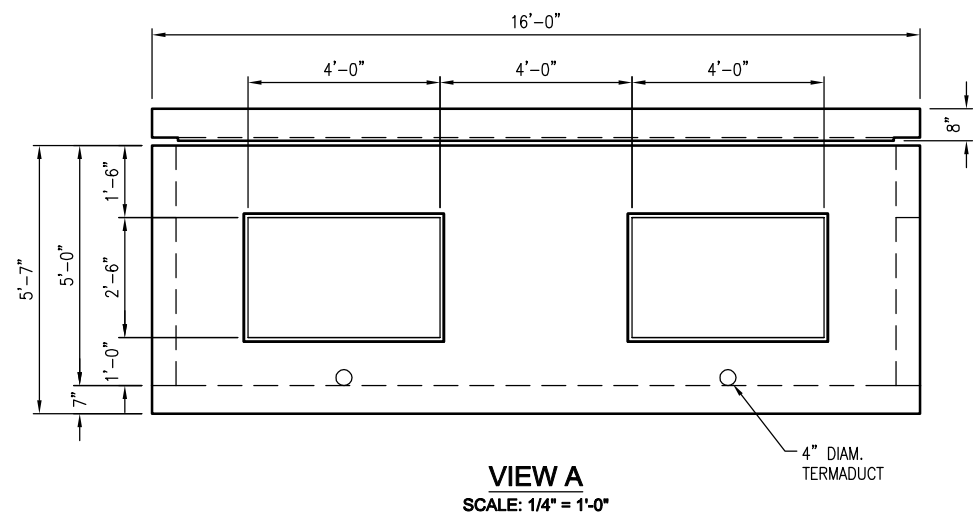
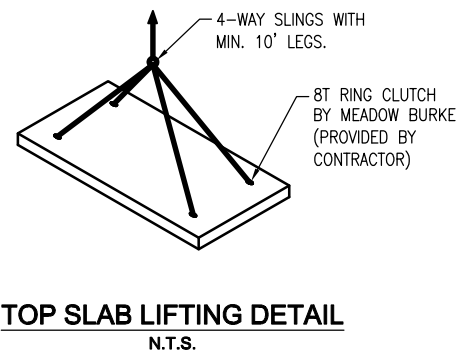
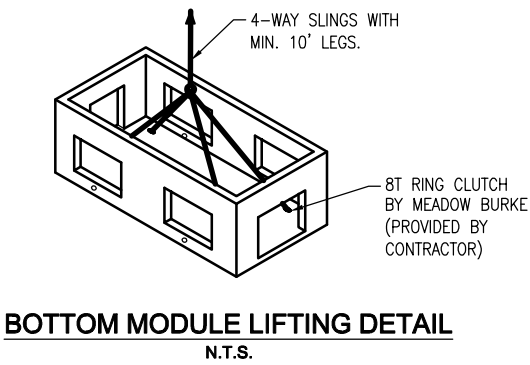
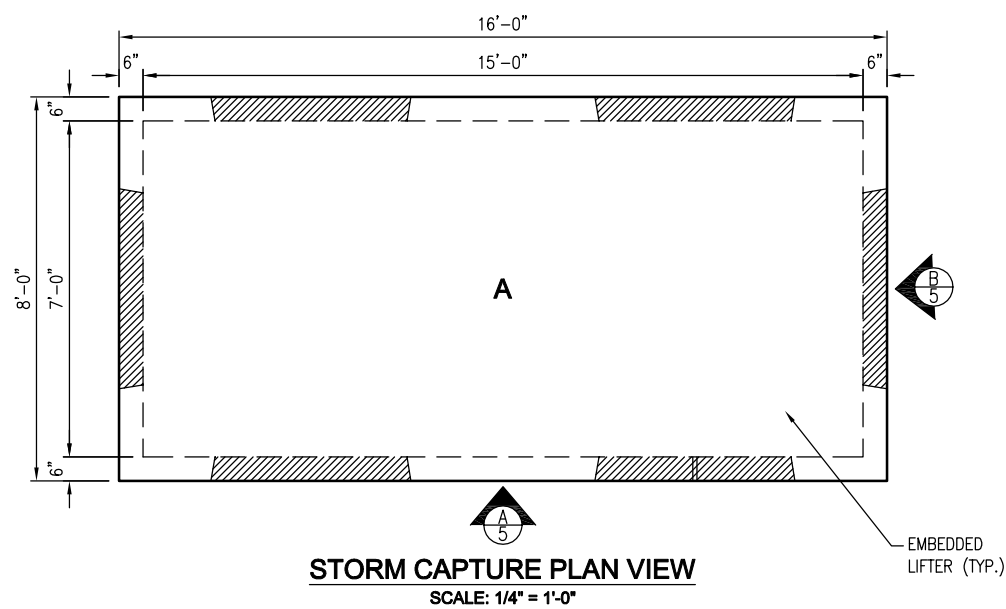


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STORMCAPTURE  
EXTERIOR DETAILS

CUSTOMER

DATE	SALES STS	DRAWN STS	ENGINEER JH	CHECKED	SALES ORDER
DRAWING NUMBER				REVISION	SHEET
SC - 5 ft base with top slab				REV DATE	3 OF 4



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**STORMCAPTURE**  
INTERIOR DETAILS

CUSTOMER					
DATE	SALES	DRAWN	ENGINEER	CHECKED	SALES ORDER
	STS	STS	JH		
DRAWING NUMBER				REVISION	SHEET
SC - 5 ft base with top slab				REV DATE	4 OF 4